# JONES BUILD HOUSE —

#### **GENERAL NOTES**

- 1. ALL WORK SHALL MEET STATE, LOCAL CODES, ORDINANCES, AND 2015 IBC.
- 2. ALL MECHANICAL, ELECTRICAL, AND PLUMBING WORK SHALL MEET ALL APPLICABLE STATE AND LOCAL CODES.
- 3. ALL UTILITIES SHALL BE PROPERLY IDENTIFIED AND LOCATED BEFORE WORK BEGINS ON THE PROJECT.
- 4. CONTRACTOR SHALL VERIFY ALL CONDITIONS AND DIMENSIONS AT THE JOB SITE AND NOTIFY DESIGNER OF ANY DIMENSIONAL ERRORS, OMMISIONS, OR DISCREPANCIES BEFORE BEGINING ANY WORK.
- 5. SCALE ON DRAWINGS AS INDICATED ON DRAWINGS, WHEN PRINTED FULL SIZE ON TABLOID (11" X 17") PAPER.

## Area Schedule

Name	Area

589 SF
1256 SF
408 SF
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# BURLEY, ID






131 S 600 E BURLEY, ID 83318 P: 208-300-0040 Jones Build House

	No.	Description	Date		
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Cover Sheet				
Project number	Project Number			9
Date	January 17, 2021		100	
Drawn by	Jason Jones		100	3
Checked by	NS	Scale		

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#### GENERAL NOTES

- 1. COORDINATE KITCHEN AND BATHROOM DESIGN AND LAYOUT WITH OWNER.
- 2. WINDOWS MARKED AS EGRESS SHALL MEET REQUIREMENTS OF THE 2012 IRC.
- 3. SMOKE ALARMS AS LOCATED SHALL SOUND AN AUDIBLE ALARM IN ALL SLEEPING AREAS PER 2012 IRC AND BE HARD WIRED WITH BATTERY BACKUP.
- 4. BATH AND RANGE HOOD FANS INDICATED SHALL VENT TO OUTSIDE AND MEET ALL REQUIREMENTS OF THE 2012 IRC. SMOOTH PIPING AND MIN 50 CFM.
- 5. VENT DRYER EXHAUST TO DUCT IN WALL AND VENT OUTSIDE.
- 6. PROVIDE SHELF AND ROD IN CLOSETS AS INDICATED.
- 7. ALL WINDOWS AND EXTERIOR DOOR HEADERS ARE DOUBLE 2X10'S OR EQUIVALENT.
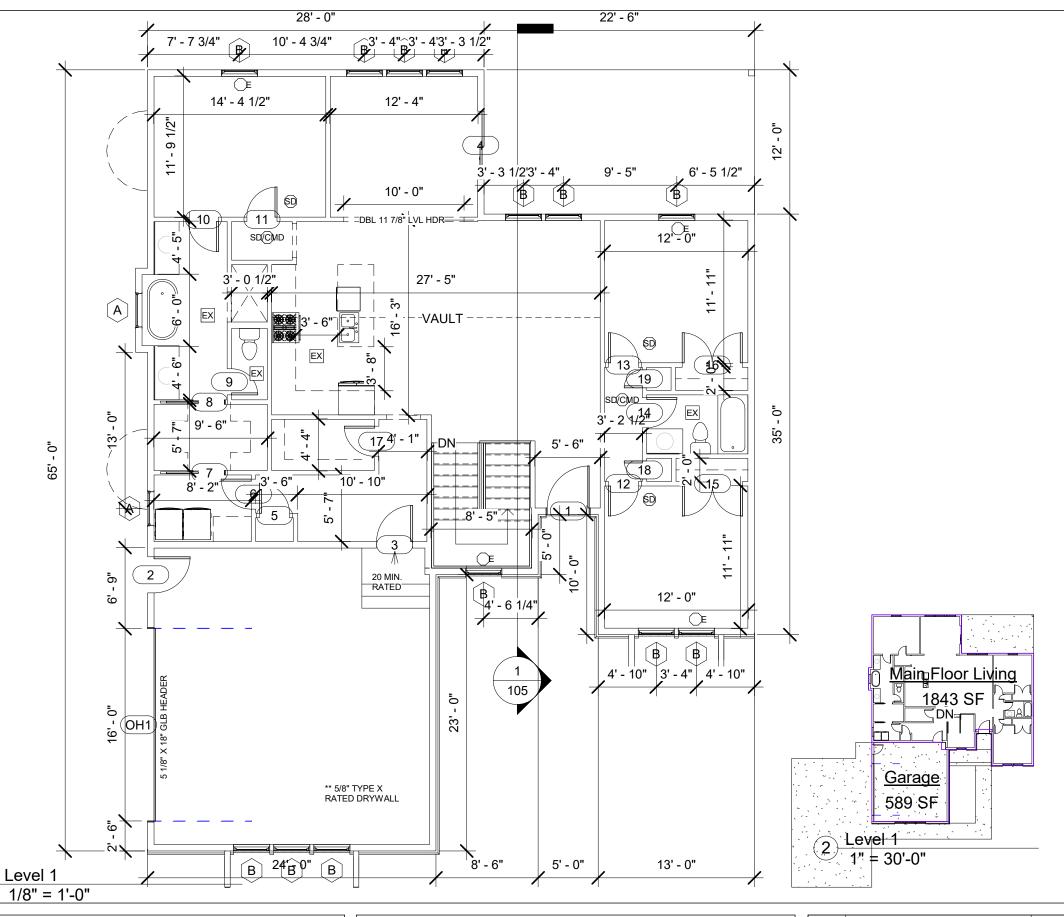
#### ENERGY NOTE:

FOR ENERGY COMPLIANCE USE PERSCRIPTIVE METHODS: R-13 BASEMENT WALLS R-30 IN FLOORS R-21 IN WALLS R-38 IN CEILING .35 MIN LOW-E WINDOWS

#### SYMBOL LEGEND

SDCMD SMOKE/ CARBON MONOXIDE DETECTOR

(SD)

SMOKE DETECTOR

E

EXHAUST FAN

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EGRESS WINDOW/ DOOR




131 S 600 E BURLEY, ID 83318 P: 208-300-0040 Jones Build House

Description	Date
	Description

Main Level Layout		
Project number	Project Number	
Date	January 17, 2021	101
Drawn by	Jason Jones	
Checked by	Checker	Scale As indicated

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#### **GENERAL NOTES**

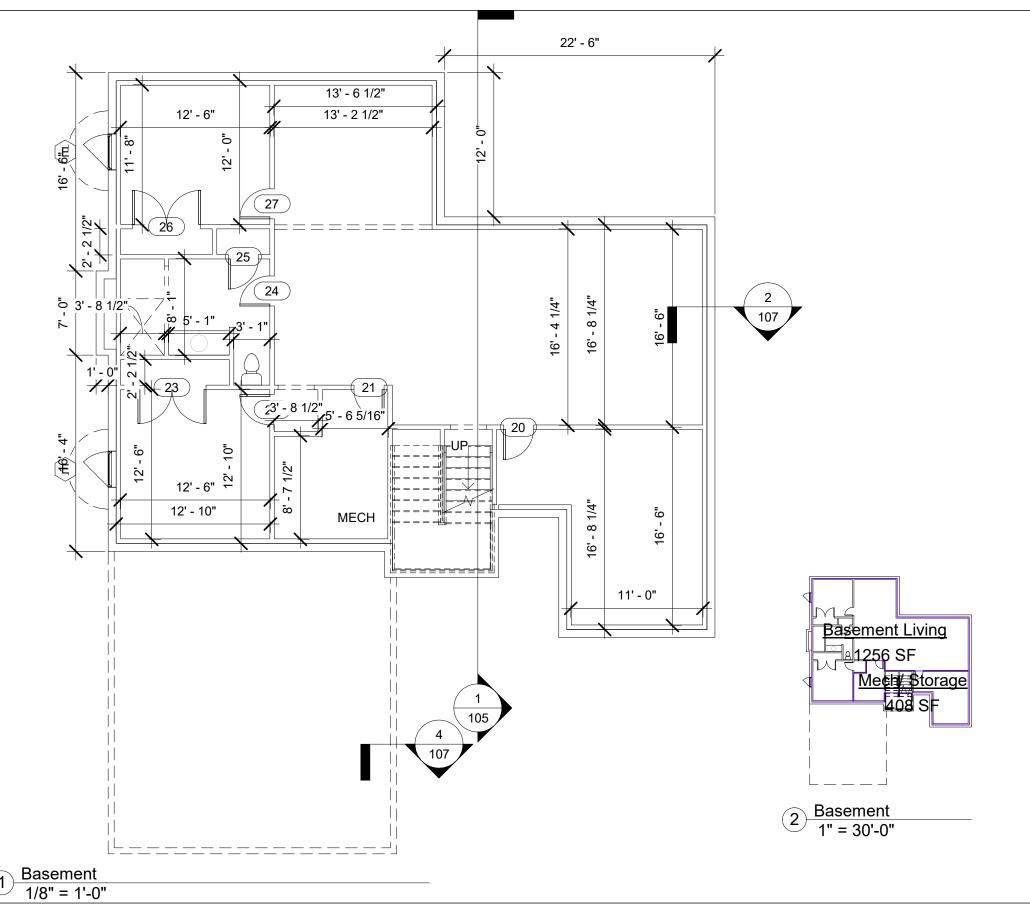- 1. COORDINATE KITCHEN AND BATHROOM DESIGN AND LAYOUT WITH OWNER.
- 2. WINDOWS MARKED AS EGRESS SHALL MEET REQUIREMENTS OF THE 2012 IRC.
- 3. SMOKE ALARMS AS LOCATED SHALL SOUND AN AUDIBLE ALARM IN ALL SLEEPING AREAS PER 2012 IRC AND BE HARD WIRED WITH BATTERY BACKUP.
- 4. BATH AND RANGE HOOD FANS INDICATED SHALL VENT TO OUTSIDE AND MEET ALL REQUIREMENTS OF THE 2012 IRC. SMOOTH PIPING AND MIN 50 CFM.
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- 6. PROVIDE SHELF AND ROD IN CLOSETS AS INDICATED.
- 7. ALL WINDOWS AND EXTERIOR DOOR HEADERS ARE DOUBLE 2X10'S OR EQUIVALENT.

#### ENERGY NOTE:

FOR ENERGY COMPLIANCE USE PERSCRIPTIVE METHODS: R-13 BASEMENT WALLS R-30 IN FLOORS R-21 IN WALLS

R-21 IN WALLS R-38 IN CEILING .35 MIN LOW-E WINDOWS

#### SYMBOL LEGEND

SD/CMD SMOKE/ CARBON MONOXIDE DETECTOR

Scale As indicated

SMOR

SMOKE DETECTOR

EX

Checker

Checked by

EXHAUST FAN

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EGRESS WINDOW/ DOOR



131 S 600 E BURLEY, ID 83318 P: 208-300-0040 Jones Build House

No.	Description	Date

# Project number Project Number Date January 17, 2021 Drawn by Author

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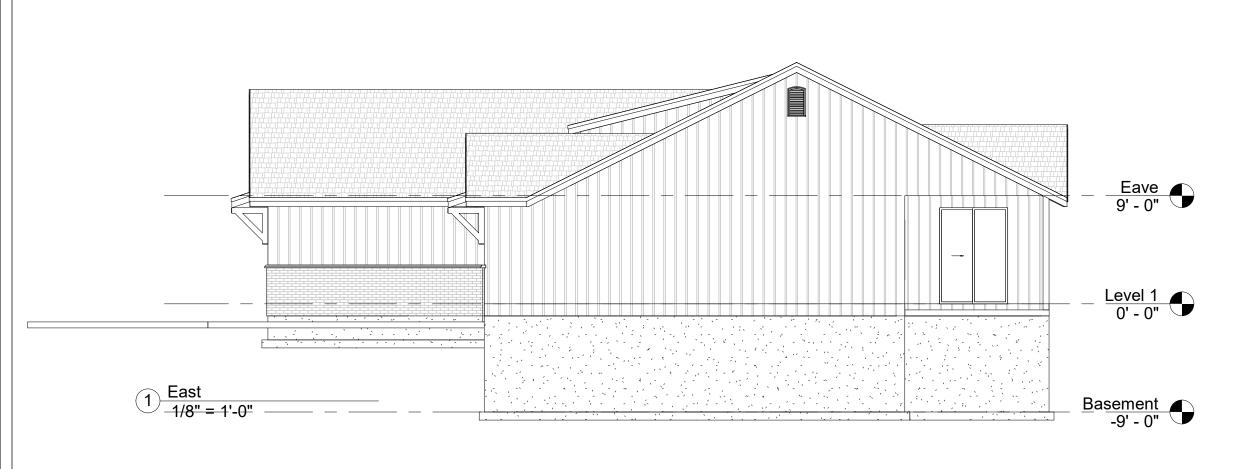






No.	Description	Date

Elevation	าร		
Project number	Project Number	4.0.0	6:32:59
Date	January 17, 2021	103	6:9
Drawn by	Jason Jones		)22
Checked by	NS	Scale 1/8" = 1'-0"	9/2022
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No.	Description	Date

Elevations		
Project number	Project Number	
Date	January 17, 2021	104
Drawn by	Jason Jones	
Checked by	NS	Scale 1/8" = 1'-0"

#### 4. BATH AND RANGE HOOD FANS INDICATED SHALL VENT TO OUTSIDE AND MEET ALL REQUIREMENTS OF THE 2012 IRC. SMOOTH PIPING AND MIN 50 CFM. 5. VENT DRYER EXHAUST TO DUCT IN WALL AND VENT OUTSIDE. 6. PROVIDE SHELF AND ROD IN CLOSETS AS INDICATED. 7. ALL WINDOWS AND EXTERIOR DOOR HEADERS ARE DOUBLE 2X10'S OR EQUIVALENT. **ENERGY NOTE:** FOR ENERGY COMPLIANCE USE PERSCRIPTIVE METHODS: R-13 BASEMENT WALLS PRE-ENG WOOD TRUSSES 2' OC 5/8" OSB SHEATHING R-30 IN FLOORS R-21 IN WALLS R-38 IN CEILING 30 YR. ARCH. SHINGLES .35 MIN LOW-E WINDOWS DUMMY DORMER Eave 9' - 0" 7/16" OSB SHEATHING DOUBLE 2X10 BOX HDR AT ALL EXT. OPENINGS 4 INSULATE HEADERS EXTERIOR FINISHES TO BE SELECTED BY OWNER <u></u> 2X6 16" OC ō 6X6 WOOD POST W/ POST WRAP THIN BRICK VENEER 7/16" OSB 2X6 16" OC SIMPSON EPB66 CAST IN R-21 FIBERGLASS PLACE BRACKET INSULATION-11 7/8 TJI 16" OC PRESSURE TREATED PLATE PRESSURE TREATED PLATE œ Basement -9' - 0"



Jones Build House

No.	Description	Date	
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Section View					
Project number	Project Number	–			
Date	January 17, 2021	105			
Drawn by	Jason Jones	100			
Checked by	NS	Scale 3/16" = 1'-0"			

**GENERAL NOTES** 

COORDINATE KITCHEN AND BATHROOM DESIGN AND LAYOUT WITH OWNER.
 WINDOWS MARKED AS EGRESS SHALL MEET REQUIREMENTS OF THE 2012 IRC.
 SMOKE ALARMS AS LOCATED SHALL SOUND AN AUDIBLE ALARM IN ALL SLEEPING

AREAS PER 2012 IRC AND BE HARD WIRED WITH BATTERY BACKUP.

Door Schedule							
Mark	Width	Height	Comments				

1	3' - 6"	8' - 0"	Entry Door Selected by Owner
2	3' - 0"	8' - 0"	
3	3' - 0"	6' - 8"	
4	5' - 8"	8' - 0"	Sliding Glass Patio Door
5	2' - 6"	8' - 0"	
6	2' - 6"	8' - 0"	
7	2' - 8"	7' - 0"	Pocket Door
8	2' - 8"	7' - 0"	Pocket Door
9	2' - 2"	8' - 0"	
10	2' - 6"	8' - 0"	
11	2' - 6"	8' - 0"	
12	2' - 6"	8' - 0"	
13	2' - 6"	8' - 0"	
14	2' - 6"	8' - 0"	
15	5' - 0"	8' - 0"	
16	5' - 0"	8' - 0"	
17	2' - 6"	8' - 0"	
18	1' - 6"	8' - 0"	
19	1' - 6"	8' - 0"	
20	2' - 6"	6' - 8"	
21	2' - 6"	6' - 8"	
22	2' - 6"	6' - 8"	
23	5' - 8"	6' - 8"	
24	2' - 6"	6' - 8"	
25	2' - 6"	6' - 8"	
26	5' - 8"	6' - 8"	
27	2' - 6"	6' - 8"	
OH1	16' - 0"	8' - 0"	

Window Schedule						
Type Mark	Comments					

1 JPO Mark	Widti	1 1019111	Operation	Committee
A	3' - 0"	3' - 0"	Fixed	
В	3' - 0"	5' - 0"	Double Hung	
С	2' - 0"	2' - 0"	Fixed	
Е	3' - 0"	4' - 0"	Casement	


Area Schedule				
Name	Area			

Main Floor Living	1843 SF
Garage	589 SF
Basement Living	1256 SF
Mech/ Storage	408 SF



No.	Description	Date

Schedules					
Project number	Project Number				
Date	January 17, 2021 106				
Drawn by	Jason Jones		100		
Checked by	NS	Scale			

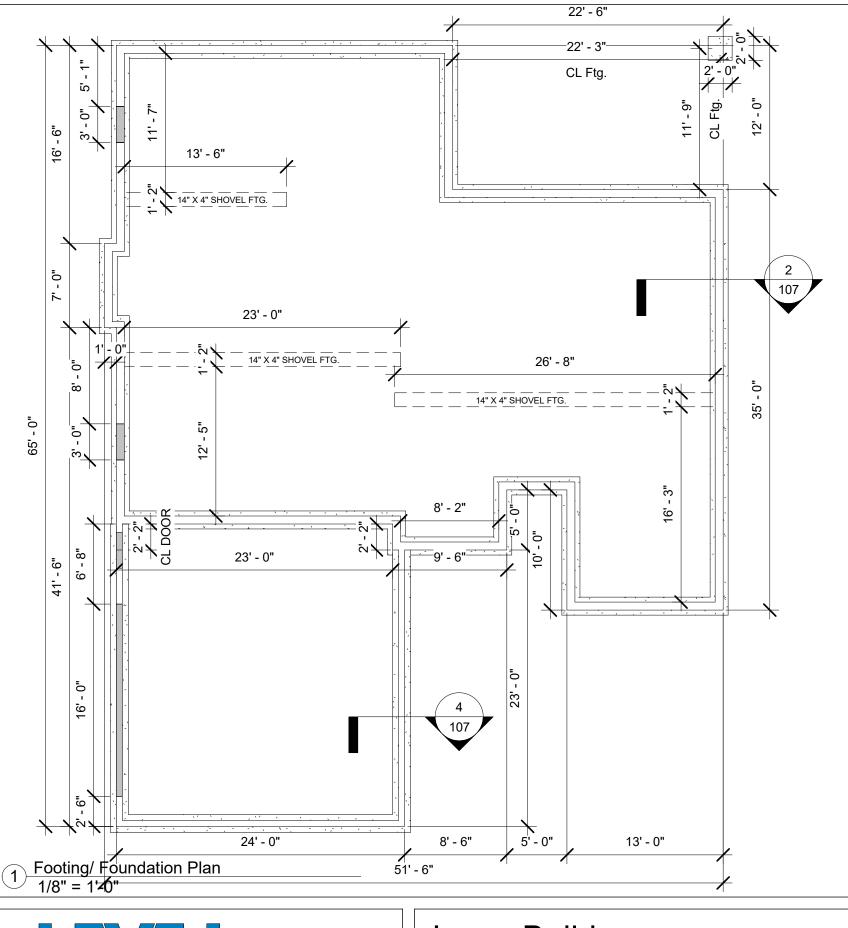

#4 VERT REBAR GRADE 60 30" OC


#4 REBAR CONT 24" OC.

(2) EA #4 REBAR CONT.

#### FOUNDATION NOTES

- VERIFY GARAGE DOOR BLOCKOUT SIZES WITH MANUFACTURER/ SUPPLIER.
- 2. PROVIDE EXPANSION JOINTS IN ALL FLATWORK AS NECESSARY.
- 3. COORDINATE EXACT LOCATION OF SIDEWALKS WITH OWNER.
- 4. ALL FOUNDATION WALLS 6" THICK W/ (2) #4 BARS SPACED EQUALLY, RUNNING CONT. FOOTINGS ARE 6" X 18" W/ (2) #4 CONT. BARS. BASEMENT FOUNDATION WALLS 8" THICK W/ (5) #4 BARS SPACED EQUALLY, RUNNING CONT.
- 5. GARAGE FLOOR SHALL BE 5" THICK OVER 4" COMPACTED GRAVEL. BASEMENT FLOOR SHALL BE 4" THICK OVER 4" COMPACTED GRAVEL. PORCH AND PATIO SHALL BE 4" THICK OVER 4" COMPACTED GRAVEL.
- 6. PROVIDE CONTINUOUS CRAWLSPACE VAPOR BARRIER OF 6 MIL VISOLIEEN
- 7. ALL FOUNDATION WALLS SHALL BE MIN. 3,000 PSI COMPRESSIVE STRENGTH @ 28 DAYS. ANY PORCHES, PARKING SLABS, STEPS, AND GARAGE FLOOR SLABSSHALL BE MIN 3,500 PSI COMPRESSIVE STRENGTH @ 28 DAYS
- 8. 5/8" X 10" AB @ 48" O.C. MAX. EACH SECTION OF SILL PLATE MUST HAVE MIN. (2) ANCHOR BOLTS. MAX DISTANCE FROM END OF ANY SILL PLATE TO AB SHALL BE 12".
- 9. VERTICAL #4 BARS @ 24" O.C. AS SHOWN ON FOUNDATION WALLS.
- 10. EXTERIOR OF ALL BASEMENT FOUNDATION WALLS SHALL BE COATED WITH APPROVED DAMP PROOFING PRODUCT.

2 Basement Ftg./ Fdtn. Detail 1/2" = 1'-0"

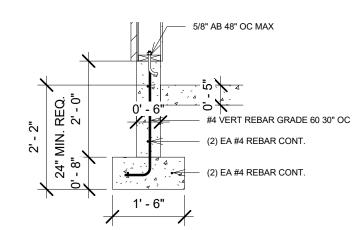


Garage Ftg./ Fdtn. Detail
1/2" = 1'-0"



131 S 600 E BURLEY, ID 83318 P: 208-300-0040

No.	Description	Date
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Footing/ Foundation Plan					
Project number	Project Number				
Date	January 17, 2021	107			
Drawn by	Jason Jones	101			
Checked by	Checker	Scale As indicated			

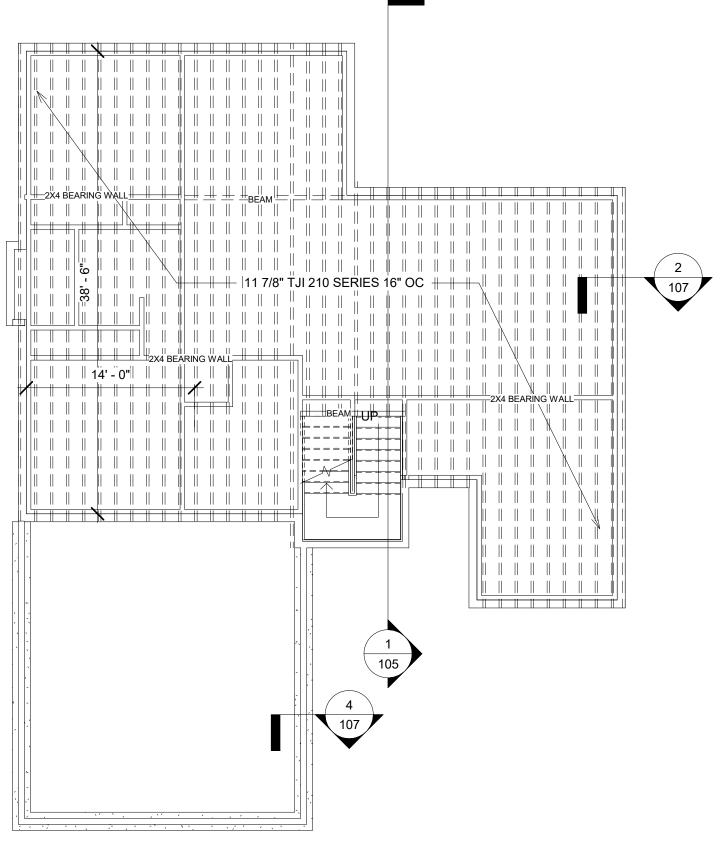

### L/480 Live Load Deflection

E/100 Live Load Defication									
Donth	TJI®	40 P	PSF Live Load / 10 PSF Dead Load			40 PSF Live Load / 20 PSF Dead Load			
Depth	ارا	12" o.c.	16" o.c.	19.2" o.c.	24" o.c.	12" o.c.	16" o.c.	19.2" o.c.	24" o.c.
	110	16'-5"	15'-0"	14'-2"	13'-2"	16'-5"	15'-0"	13'-11"	12'-5"
91/2"	210	17'-3"	15'-9"	14'-10"	13'-10"	17'-3"	15'-9"	14'-10"	13'-8"
	230	17'-8"	16'-2"	15'-3"	14'-2"	17'-8"	16'-2"	15'-3"	14'-2"
	110	19'-6"	17'-10"	16'-10"	15'-5"(1)	19'-6"	17'-3"	15'-8"	14'-0"(1)
	210	20'-6"	18'-8"	17'-8"	16'-5"	20'-6"	18'-8"	17'-3"	15'-5"(1)
117/8"	230	21'-0"	19'-2"	18'-1"	16'-10"	21'-0"	19'-2"	18'-1"	16'-3"(1)
	360	22'-11"	20'-11"	19'-8"	18'-4"	22'-11"	20'-11"	19'-8"	17'-10"(1)
	560	26'-1"	23'-8"	22'-4"	20'-9"	26'-1"	23'-8"	22'-4"	20'-9"(1)
	110	22'-2"	20'-3"	18'-9"	16'-9"(1)	21'-8"	18'-9"	17'-1"(1)	14'-7"(1)
	210	23'-3"	21'-3"	20'-0"	18'-4"(1)	23'-3"	20'-7"	18'-9"(1)	16'-2"(1)
14"	230	23'-10"	21'-9"	20'-6"	19'-1"	23'-10"	21'-8"	19'-9"	17'-1"(1)
	360	26'-0"	23'-8"	22'-4"	20'-9"(1)	26'-0"	23'-8"	22'-4"(1)	17'-10"(1)
	560	29'-6"	26'-10"	25'-4"	23'-6"	<i>29'-6"</i>	<i>26'-10"</i>	25'-4"(1)	20'-11"(1)
	210	25'-9"	23'-6"	22'-0"(1)	19'-5"(1)	25'-5"	22'-0"(1)	20'-1"(1)	16'-2"(1)
16"	230	26'-5"	24'-1"	22'-9"	20'-7"(1)	26'-5"	23'-2"	21'-2"(1)	17'-1"(1)
10	360	28'-9"	26'-3"	24'-8"(1)	21'-5"(1)	28'-9"	26'-3"(1)	22'-4"(1)	17'-10"(1)
	560	32'-8"	29'-8"	28'-0"	25'-2"(1)	32'-8"	29'-8"	26'-3"(1)	20'-11"(1)


Floor Framing Plan 1/8" = 1'-0"



131 S 600 E BURLEY, ID 83318 P: 208-300-0040


No.	Description	Date


Project number Project Number	100	
Date January 17, 2021	108	
Drawn by Jason Jones		
Checked by NS	Scale 1/8" = 1'-0"	

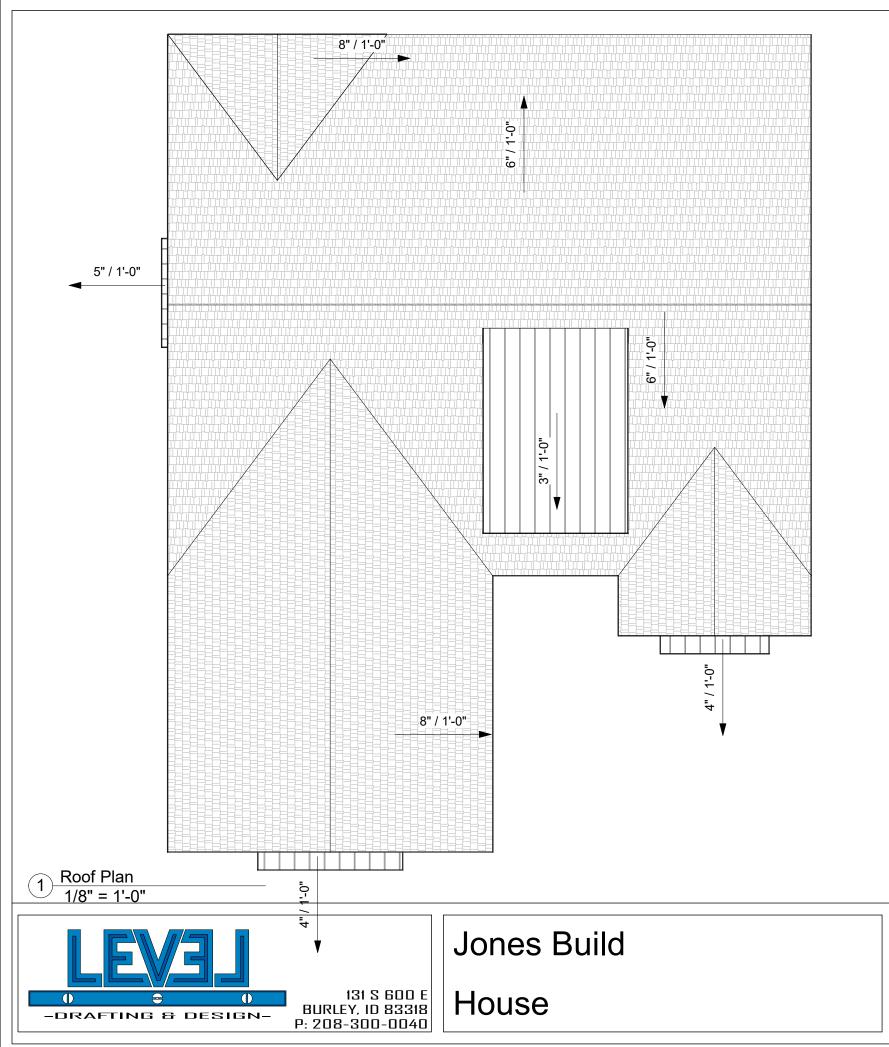

No. Description Date

Roof Pla	n	
Project number	Project Number	1.0.0
Date	January 17, 2021	109
Drawn by	Jason Jones	
Checked by	NS	Scale 1/8" = 1'-0"

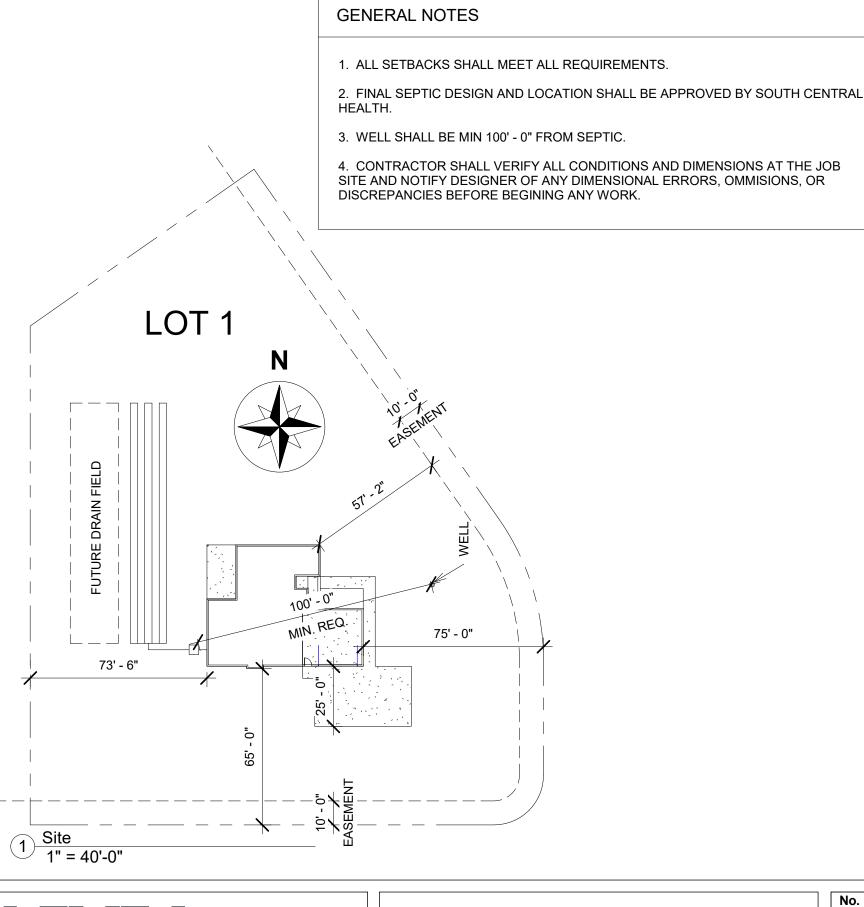

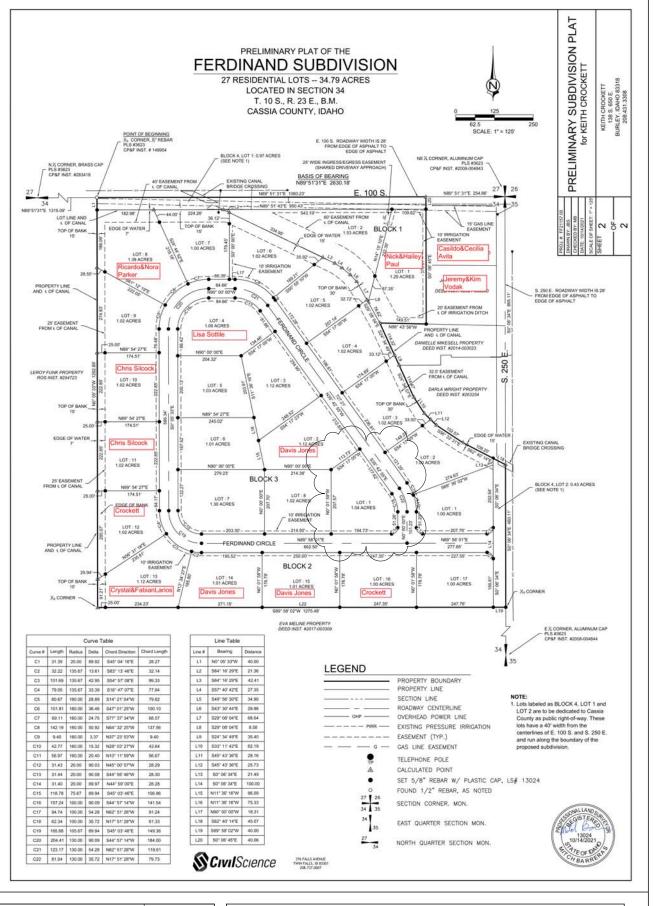



Jones Build

House

No.	Description	Date
1	Revision 1	Date 1

Site Layout		
Project number	Project Number	
Date	January 17, 2021	SD1
Drawn by	Jason Jones	
Checked by	NS	Scale 1" = 40'-0"